

ALL CARE IS TAKEN WITH DIMENSIONS BUT NO RESPONSIBILITY ACCEPTED FOR DISCREPANCIES. MEASUREMENTS TAKE PRECEDENCE OVER SCALE.
IT IS THE TENDER'S RESPONSIBILITY

TO CHECK ALL ON SITE HEIGHTS, LEVELS & MEASUREMENTS. EVERY PART OF THE BUILDING & ASSOCIATE COMPONENTS MUST BE CONSTRUCTED IN AN APPROPRIATE MANNER TO ACHIEVE THE
REQUIREMENTS OF THE HOUSING
PROVISIONS USING MATERIALS THAT
ARE FIT FOR THE PURPOSE FOR
WHICH THEY ARE INTENDED. THE BUILDING & ANY ASSOCIATED SITE WORK IS TO BE CONSTRUCTED IN A WAY THAT PROTECTS SURROUNDING OCCUPANTS & PROPERTY FROM ADVERSE EFFECTS OF REDIRECTED SURFACE WATER.
THE BUILDING IS TO BE
CONSTRUCTED TO PROVIDE
RESISTANCE TO MOISTURE FROM

OUTSIDE & MOISTURE RISING FROM THE GROUND. ANY HEATING APPLIANCE & ASSOCIATED COMPONENT MUST BE INSTALLED BY A LICENSED PERSON

& COMPLY TO BCA PART 3.10.7.
ALL CONSTRUCTION METHODS & MATERIALS MUST COMPLY TO ANY & ALL BASIX, NATHERS OR ALTERNATIVE THERMAL/ENERGY ASSESSMENTS & IT IS THE BUILDERS RESPONSIBILITY TO ENSURE ALL TRADES RECEIVE COPIES OF SUCH ASSESSMENTS. ALL EARTHWORKS ARE TO BE UNDERTAKEN STRICTLY TO COMPLY TO NCC PART 3.1.

ALL STORM WATER & SURFACE DRAINAGE IS TO BE UNDERTAKEN STRICTLY TO COMPLY TO NCC 3.1. A TERMITE BARRIER MUST BE INSTALLED STRICTLY TO COMPLY TO

NCC 3.1.
ALL CONCRETE FOOTINGS & SLABS
ARE TO BE CONSTRUCTED STRICTLY
TO BCA 3.2. & ENGINEERS
SPECIFICATIONS.

SPECIFICATIONS.
ALL MASONRY & ASSOCIATED
COMPONENTS IS TO BE
CONSTRUCTED STRICTLY TO COMPLY
TO NCC 3.3.
SUB-FLOOR VENTILATION WHERE

REQUIRED MUST COMPLY TO NCC

3.4.1.
ALL TIMBER FRAMING ,WIND BRACING & ASSOCIATED COMPONENTS MUST COMPLY TO AS1684-N1/N2-2010 OR ENGINEERS DESIGN.

ON ENGINEERS DESIGN.
ROOF CLADDING & ASSOCIATED
COMPONENTS MUST BE INSTALLED
STRICTLY AS TO COMPLY TO NCC
3.5.1. OR 3.5.2. GUTTERS, DOWN PIPES &
ASSOCIATED COMPONENTS MUST BE
INSTALLED STRICTLY AS TO COMPLY

TO NCC 3.5.3.
ALL WALL CLADDING & ASSOCIATED COMPONENTS MUST COMPLY TO NCC 3.5.4 OR 3.5.5.

ALL GLAZING IS TO COMPLY TO NCC 3.6. & ANY REQUIREMENTS UNDER BASIX, NATHERS OR ALTERNATIVE THERMAL/ENERGY ASSESSMENTS. DIRECT WIRED SMOKE DETECTORS
MUST COMPLY WITH AS3786 & BE INSTALLED AS TO COMPLY TO NCC

ALL REQUIRED AREAS ARE TO BE PROTECTED AGAINST WATER IN ACCORDANCE WITH NCC 3.8.1.2.

## PROPOSED ECO-TOURIST FACILITY FOR: Brooke McClymont & Adam Eckersley 851 Wang Wauk Road Wang Wauk

NOTIFICATION PLANS 2023-023 of 4

SCALE

**APRIL 2024** 

DRAWN BY:


1:5000 @ A3


**NEIL RYAN** 44 WOOLA ROAD TAREE Mob. 0417682880


ABN 43 831 206 704


A-4 CHECKED


Document Set ID: 17072538

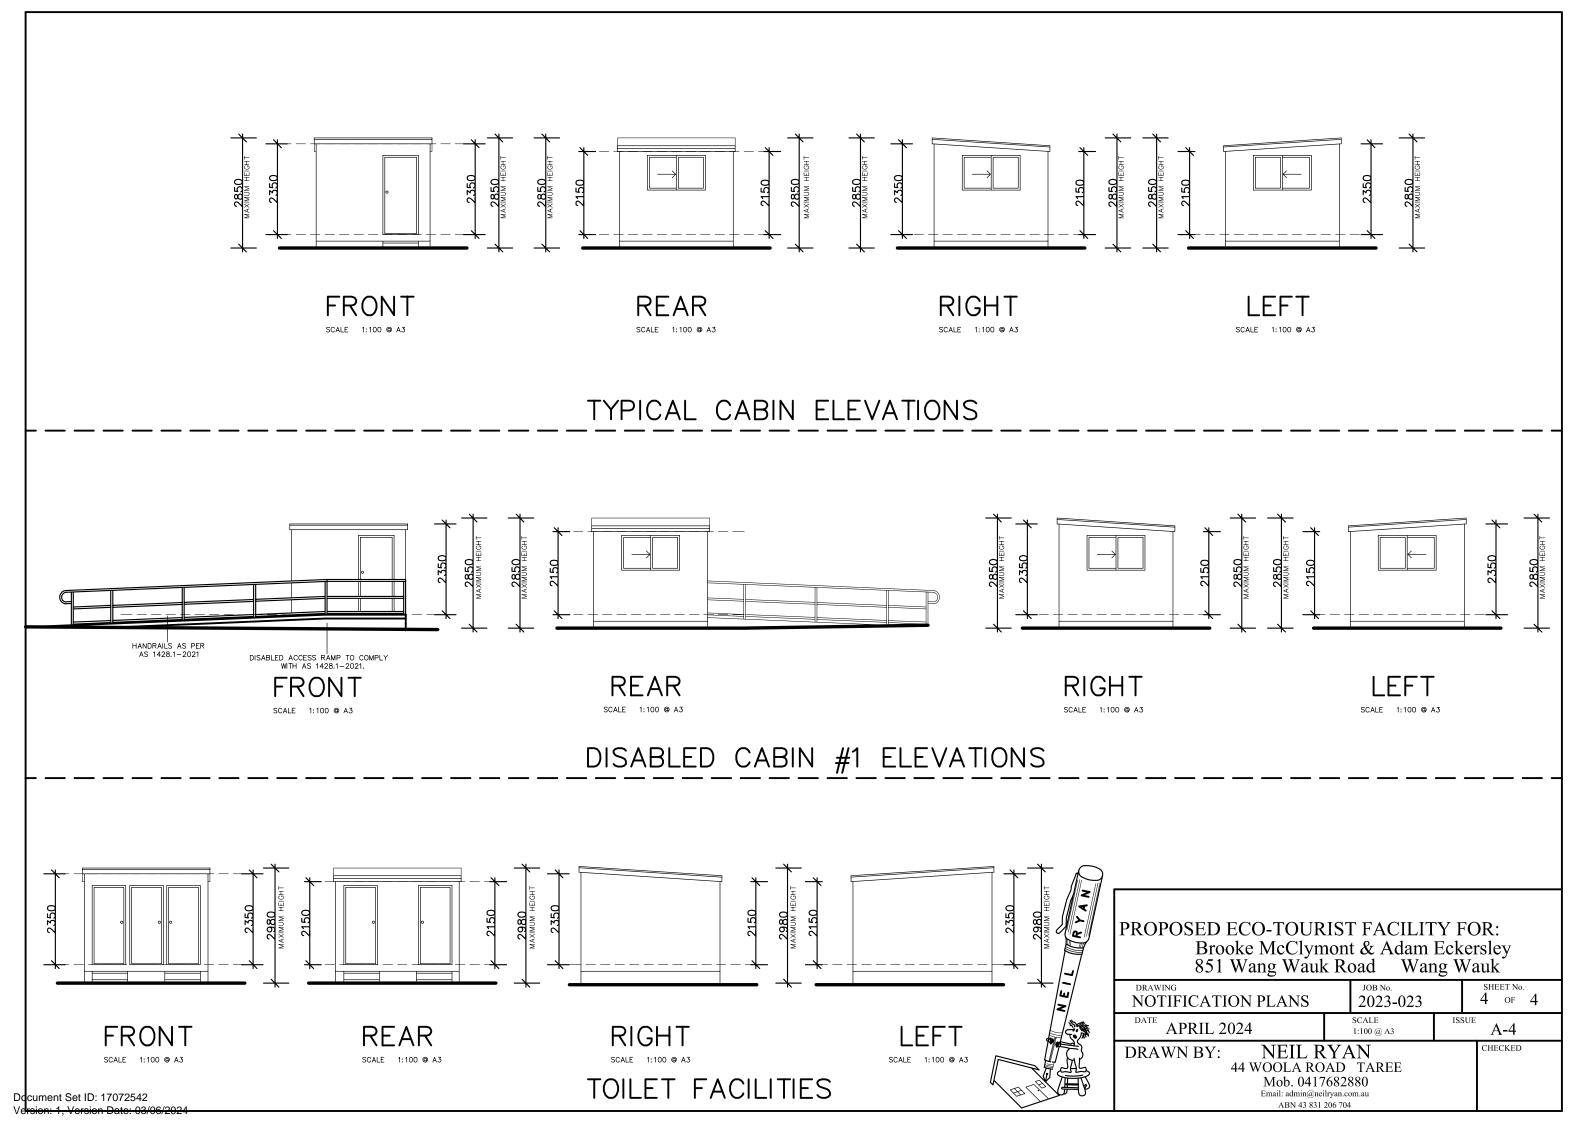

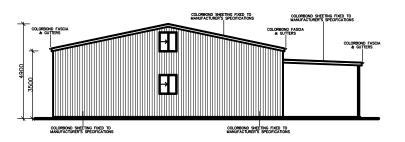

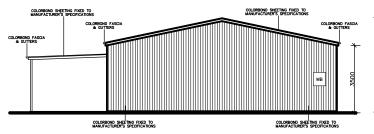

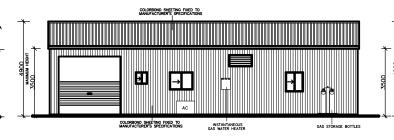

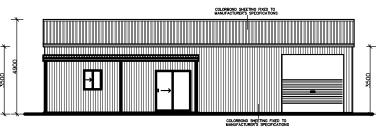

NORTH ELEVATION SCALE 1:200 @ A3

SOUTH ELEVATION


EAST ELEVATION

WEST ELEVATION


SCALE 1:200 @ A3

MANAGER'S RESIDENCE ELEVATIONS


COMMUNAL SHED ELEVATIONS

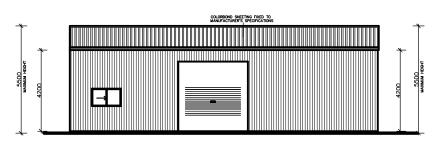

NORTH-WEST ELEVATION

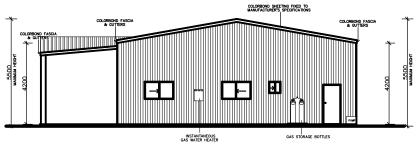

NORTH-EAST ELEVATION SCALE 1:200 @ A3

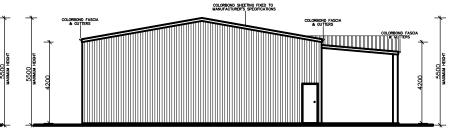

SOUTH-WEST ELEVATION

COLORBOND SHEETING FIXED TO MANUFACTURER'S SPECIFICATIONS SOUTH-EAST ELEVATION

SCALE 1: 200 @ A3



PROPOSED ECO-TOURIST FACILITY FOR: Brooke McClymont & Adam Eckersley

Wang Wauk 851 Wang Wauk Road 3 of 4

**NOTIFICATION PLANS** 

2023-023

A-4

CHECKED

**APRIL 2024** DRAWN BY:

**NEIL RYAN** 

SCALE 1:200 @ A3

44 WOOLA ROAD TAREE Mob. 0417682880 ABN 43 831 206 704

Document Set ID: 17072543

